

October 24, 2018

# COURTESY NOTICE OF ADMINISTRATIVE SITE AND ARCHITECTURAL REVIEW PERMIT APPLICATION

Notice is hereby given that the Planning Division of the Community Development Department of the City of Campbell has received an application for an Administrative Site and Architectural Review Permit for the following project proposal:

File No.: PLN2018-347

Applicant: Wise Builders

Project Address: 1620 Beth Way

Property Owner: Tao Deng

Zoning District: R-1-6 (Single Family Residential)

General Plan: Low Density Residential (San Tomas Area Neighborhood Plan)


Project Description: 356 sf addition to existing single-story home

This application has been reviewed for compliance with the applicable standards of the Campbell Municipal Code and San Tomas Area Neighborhood Plan and has been deemed complete. This project will be decided by the Community Development Director on November 6, 2018 and you have the opportunity to provide comment prior to this decision. The ten-day comment period for this application begins on October 24, 2018 and ends on November 5, 2018. Any comments regarding this application must be submitted in writing (including email) to the Planning Division before 5:00 p.m. on **November 5, 2018**. The Director will then consider all comments submitted within this time period, prior to making the decision on November 6, 2018. You will receive a second notice notifying you of the decision.

Decisions by the Community Development Director are final in 10 calendar days following the date of approval, unless an appeal is received in writing at the City of Campbell Community Development Department, 70 N. First Street, Campbell, prior to the end of the appeal period. A written appeal must be accompanied with the required \$750 appeal filing fee. Plans and architectural drawings may be viewed at the Planning Division office during normal business hours (8:00 AM – 5:00 PM) and on the City's 'Public Notices' web page (<a href="http://www.cityofcampbell.com/501/Public-Notices">http://www.cityofcampbell.com/501/Public-Notices</a>) under 'Administrative Decisions'. Questions or comments regarding this application may be addressed to Naz Pouya, Assistant Planner, in the Community Development Department, at (408) 866-2144 or by email <a href="mailto:nazp@cityofcampbell.com">nazp@cityofcampbell.com</a>.

# **Project Location Map**



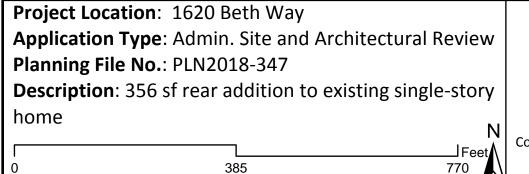





# Beth Way Residence

1620 Beth Way., Campbell, CA 95008 APN: 403-13-054



MENT					
ISION	DATE:	BY:			

EXISTING HOUSE NOT FIRE SPRINKLER

VIOLETTI MIAT:	DIVATINO INDEX.
15 mg	ARCHITECTURAL SHEETS:
	A-01 ARCHITECTI
1	A-02 ARCHITECTI
Cont   Section	A-03 ARCHITECTI
	A-04 ARCHITECTI
	A-05 ARCHITECTI
	A-5.1 ARCHITECT
	A-06 ARCHITECTI
SIE.	A-07 ARCHITECTI
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PROJE	A-09 ARCHITECTI
MACHINE MACHINE	A-10 ARCHITECTI

PARCEL MAP: PROJECT INFORMATION:

**ENGINEER:** JOSE FERNANDEZ 3001 Winchester Blvd. #3 Campbell, CA 95008

ifplans@gmail.com, 408-512-8400

DESIGNER: Wise Builders

5205 Prospect Road., San Jose, CA 95129

**TAO DENG & JINGHAO XU** 1620 Beth Way Campbell, CA 95008

PARCEL MAP: 403-13-054 V/B CONSTRUCTION TYPE: OCCUPANCY GROUP: R3/U ZONING SITE: R-1-6

AREA PLAN: SAN TOMAS AREA

HOUSE LEVEL: FIRE SPRINKLER: NONE LOT SIZE: 6861 SQ.FT

**EXISTING** 

OWNER:

BEDROOM: BATHROOM:

2 FULL BATHS GARAGE: 2 CAR ATTACHED

**PROPOSED** 

BEDROOM: BATHROOM: 1 FULL BATH STRUCTURAL SHEETS:

S-1 STRUCTURAL COVER SHEET S-2 STRUCTURAL FOUNDATION DETAILS S-3 STRUCTURAL FRAMING DETAILS S-4 STRUCTURAL FOUNDATION PLAN S-5 STRUCTURAL FRAMING PLAN

ARCHITECTURAL COVER SHEET

ARCHITECTURAL PLAN AND ROOF

ARCHITECTURAL PROPOSED PLAN

ARCHITECTURAL ELEVATIONS

ARCHITECTURAL ELEVATIONS

ARCHITECTURAL ELEVATIONS

ARCHITECTURAL FLOOR PLANS

ARCHITECTURAL ELECTRICAL PLAN

ARCHITECTURAL FLOOR AREA DIAGRAM

ARCHITECTURAL EXISTING SETBACK PLAN

TITLE 24-CALCULATIONS:

T24-1 **TITLE 24 CALCULATIONS** T24-2 **TITLE 24 CALCULATIONS** 

**BUILDING CODES:** 

2016 CALIFORNIA BUILDING CODES 2016 CALIFORNIA RESIDENTIAL CODES 2016 CALIFORNIA ELECTRICAL CODES 2016 CALIFORNIA MECHANICAL CODES 2016 CALIFORNIA PLUMBING CODES 2016 CALIFORNIA FIRE CODES 2016 CALIFORNIA EXISTING BUILDING CODES 2016 CALIFORNIA GREEN BUILDING CODES 2016 BUILDING ENERGY EFFICIENCY STANDARDS PROJECT DATA & SUMMARY: EXISTING FLOOR AREA INFORMATION.

GROSS LOT AREA: 8.196 Sa.Ft ARCHITECTURAL PROPOSED SETBACK PLAN NET LOT AREA: 6.856 Sq.Ft (E) HOUSE: 1.478 Sa.Ft (E) GARAGE: 408 Sa.Ft (E) FRONT PORCH: Sq.Ft TOTAL: 1,927 Sq. Ft

BUILDING COVERAGE: 1,927 / 6,856 = 28.10 % FAR: 1,886 / 6,856 = 0.27

BLDG HEIGHT: 14' 3"

PROJECT SCOPE OF WORK

3- REMODEL BEDROOM 3

4- REMODEL BATH 2.

FAR ALLOWED: 3.085 Sa.Ft = 0.45 MAX. HEIGHT ALLOWED: 28' FOR 2 1/2 STORIES

2- ADD 1 MASTER BEDROOM AND MASTER BATH

5- RELOCATE BATH 1 TO BE JACK & JILL. 6- (E) FRONT YARD LANDSCAPE TO REMAIN

1- ADDITION OF 356 SQ.FT OF LIVING AREA TO THE REAR SIDE OF THE HOUSE.

PROPOSED FLOOR AREA INFORMATION

PROPOSED WORK: REAR ADDITION:

356 Sq. Ft

PROPOSED DATA:

(N) HOUSE: 1.834 Sa.Ft (E) GARAGE: 408 Sq.Ft (E) FRONT PORCH: 41 Sq.Ft

TOTAL: 2,283 Sq. Ft

BUILDING COVERAGE: 2.283 / 6.856 = 33.29 % FAR: 2.242 / 6.856 = 0.32

BLDG HEIGHT 12' 10"

HEET TITLE

ROJECT:

1620 Beth Way

APN:403-13-054

Campbell, CA 95008

ARCHITECTURAL COVER SHEET


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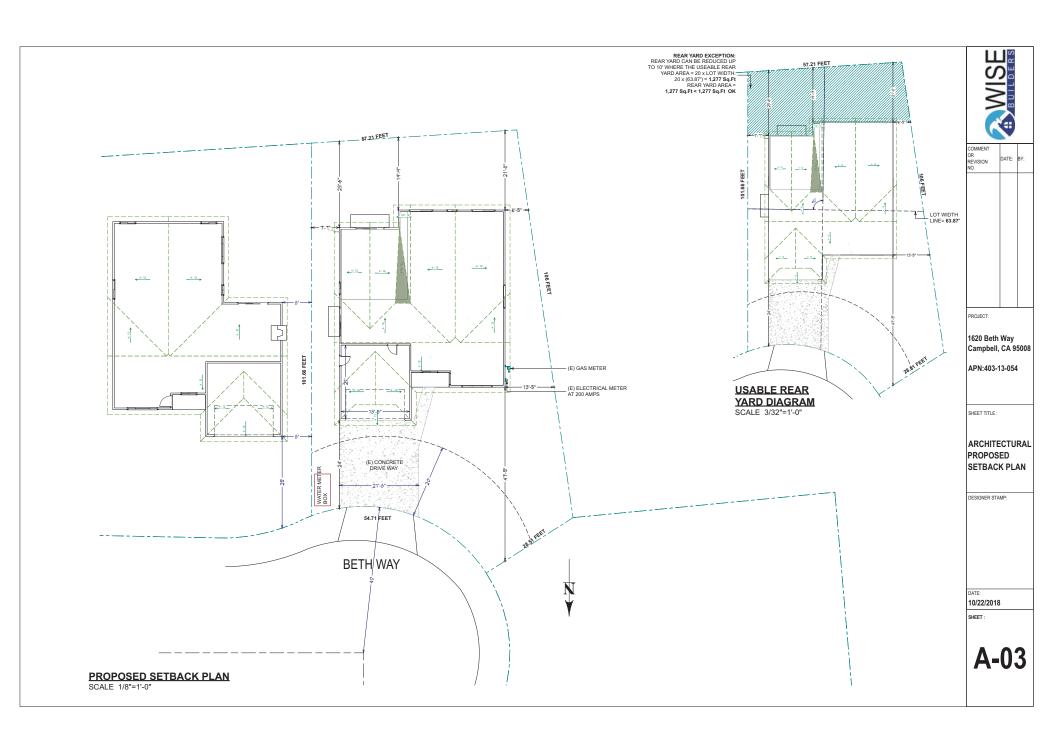
10/22/2018


THE CONTRACTOR SHALL ERECT AND MAINTAIN, AS REQUIRED BY EXISTING CONDITIONS AND PROGRESS OF THE WORK, ALL REASONABLE SAFEGUARDS FOR SAFETY AND PROTECTION INCLUDING POSTING DANGER SIGNS AND OTHER WARNINGS AGAINST HAZARDS, PROMULGATING SAFETY REGULATIONS AND NOTIFYING OWNERS AND USERS OF ADJACENT UTILITIES.

THE CONTRACTOR SHALL BE RESPONSIBLE FOR VERIFICATION OF ALL DIMENSIONS, GRADES AND OTHER CONDITIONS, AND HE SHALL CORRELATE ALL SUCH ITEMS AT THE JOB SITE. HE SHALL REPORT ANY DISCREPANCIES TO THE DESIGNER FOR CLARIFICATION AND/OR CORRECTION PRIOR TO BEGINNING ANY

THE CONTRACTOR SHALL BE RESPONSIBLE FOR THE WORK AND COORDINATION OF ALL TRADES WITH THE GOVERNING AGENCIES. AND SHALL PROVIDE ALL MATERIALS AND LABOR SHOWN IN THESE PLANS TO RENDER THE JOB COMPLETE.



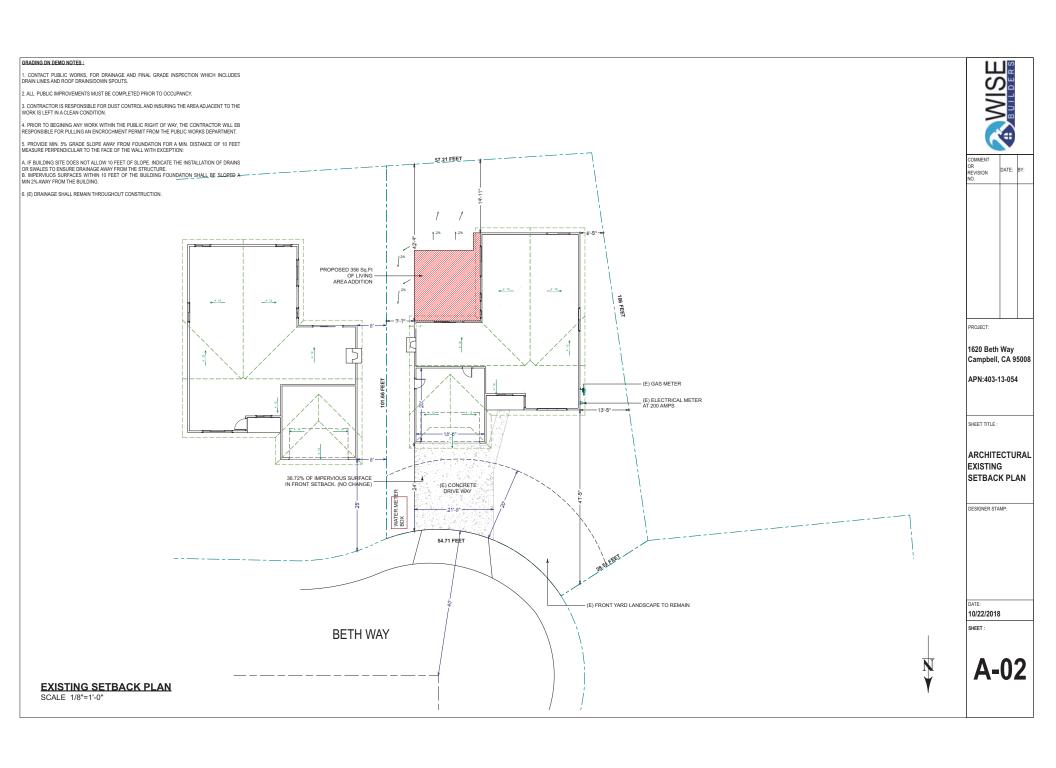

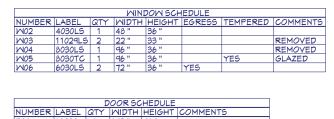

FIRE RATED 1 HR - (E)

80 " 80 "

16080 1 192" 96" 1 24 ' 1 30 '

2068

2668

3068 5068

LEGEND			
	EXISTING WALLS TO REMAIN		
YIIIIIIIIIIII	EXISTING WALLS TO BE REMOVED		



Va.		
COMMENT OR REVISION NO.	DATE:	BY:

PROJECT:

1620 Beth Way Campbell, CA 95008

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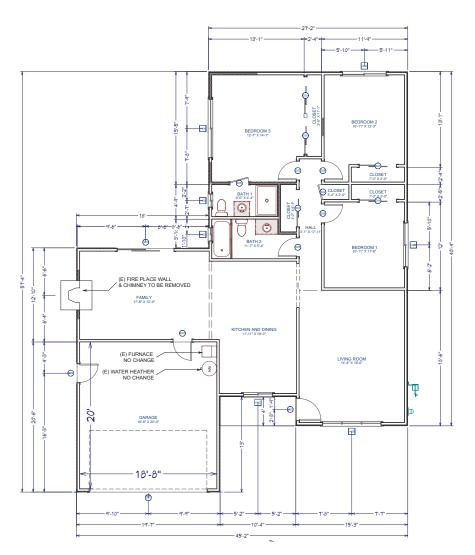
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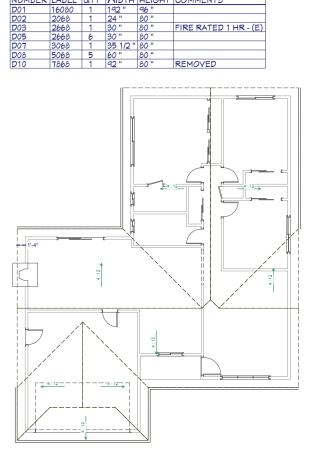
ARCHITECTURAL FLOOR PLAN EXISTING

DESIGNER STAMP:

10/22/2018

A-04






**EXISTING ROOF PLAN** 

NOT TO SCALE

**EXISTING FLOOR PLAN** 

SCALE 1/8"=1'-0"

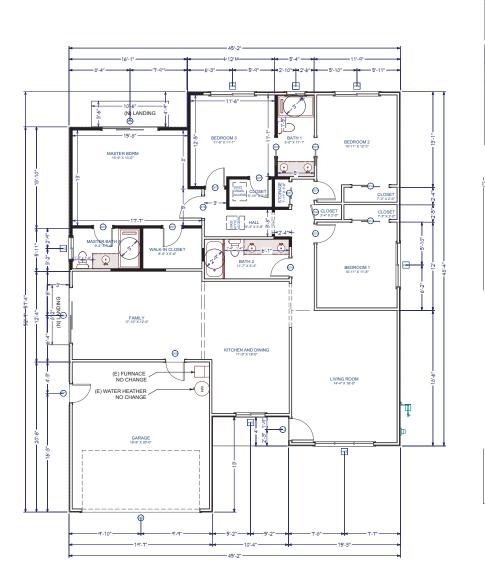


PROPOSED FLOOR PLAN

SCALE 1/8"=1'-0"

MINDOM SCHEDULE							
NUMBER	LABEL	QTY	MIDTH	HEIGHT	EGRESS	TEMPERED	COMMENTS
M01	2620LS	1	30 "	24 "		YES	GLAZED
M02	3020LS	1	36 "	24 "		YES	GLAZED
M03	4030LS	1	48 "	36 "			
M05	8030TC	1	96 "	36 "		YES	GLAZED
M06	6030LS	3	72 "	36 "	YES		

7 100	000000		12	100	1123			
	DOOR SCHEDULE							
NUMBER	LABEL	QTY	MIDTH	HEIGHT	COMMEN.	TS .		
D01	(N) 7668	1	90 "	80 "				
D02	16080	1	192 "	96 "				
D03	2668	1	30 "	80 "	FIRE RAT	ED - EXISTING	5	
D04	2068	1	24 "	80 "				
D07	2668	10	30 "	80 "				
D12	3068	1	35 1/2 "	80 "				
D13	3068	2	36 "	80 "				
D14	5068	2	60 "	80 "				
D15	7668	1	90 "	80 "	EGRESS			

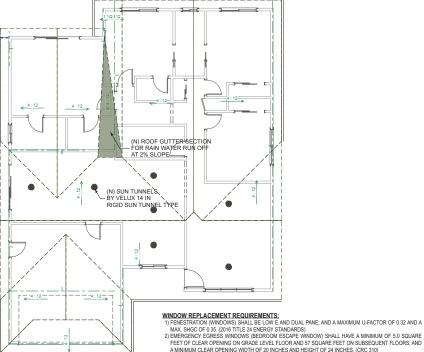

# 

NOT TO SCALE

LEGEND

EXISTING WALLS TO REMAIN NEW WALL

COMMENT OR REVISION NO.	DATE:	BY:			

1620 Beth Way Campbell, CA 95008

APN:403-13-054

SHEET TITLE :

ARCHITECTURAL FLOOR PLAN PROPOSED

DESIGNER STAMP:

10/22/2018

SHEET

R311.3.1 FLOOR ELEVATIONS AT REQUIRED EGRESS DOORS.

R311.3.1 FLOOR ELEVATIONS AT REQUIRED EGRESS DOORS.

HAUDINGS OR FLOORS AT THE REQUIRED EGRESS DOORS. SHALL NOT BE MORE THAN 1.1/2 INCHES LOWER THAN THE TOP OF THE THRESHOLD. EXCEPTION: THE EXTERIOR LANDING OR FLOOR SHALL NOT BE MORE THAN 7.34" MICHELS BELOW THE TOP OF THE THESHOLD. PROVIDED THE DOOR DOES NOT SWING OVER THE


RESIDENTIAL LANDINGS & THRESHOLDS SECTIONS R311.3 & R311.7.6

3) GLAZING SHALL BE TEMPERED IF: (CRC R308) LOCATED IN THE WILD-LAND URBAN INTERFACE AREA, LOCATED LESS THAN 60 INCHES MEASURED VERTICALLY, ABOVE WALKING SURFACE OF SHOWER/TUB/ STEAM ROOF, ETC., LOCATED IN HAZARDOUS LOCATIONS AS INDICATED PER CRET 60394.

4) PROVIDE A FALL PREVENTION DEVICE IF THE OPENING IS LOCATED MORE THAN 72 INCHES ABOVE THE FINISHED GRADE AND THE LOWEST PART OF CLEAR OPENING IS LESS THAN 24 INCHES ABOVE FINISHED FLOOR, (CRC R312.2)

**PROPOSED ROOF PLAN** 

**A-05** 

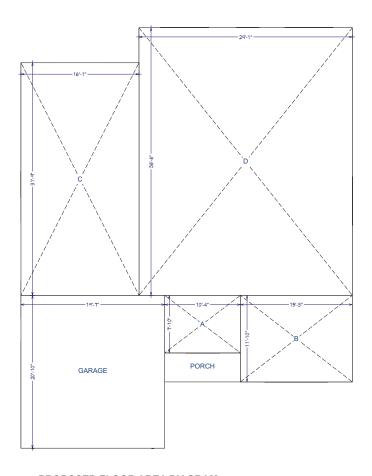

FLOOR AREA DIAGRAM CALCULATIONS					
AREA NAME	DIMENSIONS	SQ	.FT		
Α	7' 10" x 10' 4" =	81	Sq.Ft		
В	11' 10" x 15' 3" =	180	Sq.Ft		
С	31' 9" x 16' 1" =	511	Sq.Ft		
D	36' 6" x 29' 1" =	1062	Sq.Ft		
TC	TAL	1834	Sq.Ft		

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COMMENT OR REVISION NO.	DATE:	BY:

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APN:403-13-054

SHEET TITLE :


ARCHITECTURAL FLOOR AREA DIAGRAM

DESIGNER STAMP:

10/22/2018


A-5.1

PROPOSED FLOOR AREA DIAGRAM N.T.S.

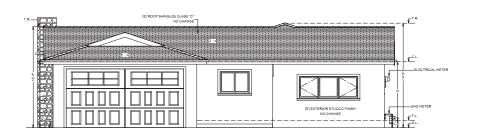


# EXISTING FRONT ELEVATION. NO CHANGE

SCALE 1/4"=1'-0"

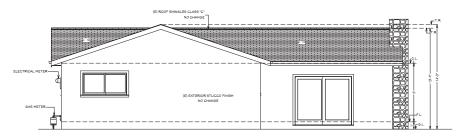


# **EXISTING REAR ELEVATION**

SCALE 1/4"=1'-0"

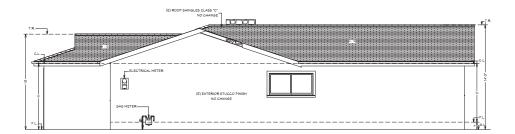

# EXISTING RIGHT ELEVATION. NO CHANGE

SCALE 1/4"=1'-0"

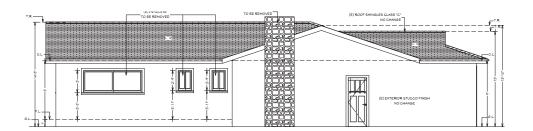

# EXISTING LEFT ELEVATION SCALE 1/4"=1'-0"

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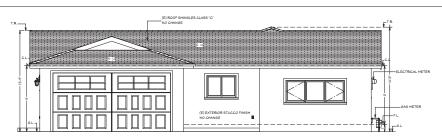
SHEET TITLE :

ARCHITECTURAL ELEVATION EXISTING

DESIGNER STAMP:


10/22/2018

**A-06** 




### PROPOSED FRONT ELEVATION

SCALE 1/4"=1'-0"

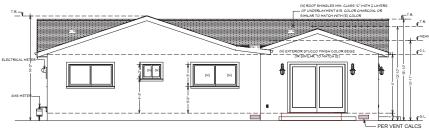

# PROPOSED REAR ELEVATION

SCALE 1/4"=1'-0"

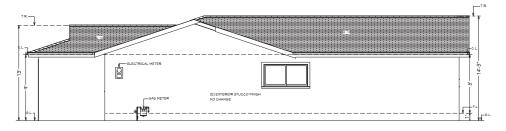

### PROPOSED RIGHT ELEVATION

SCALE 1/4"=1'-0"



### PROPOSED LEFT ELEVATION

SCALE 1/4"=1'-0"

#### **ELEVATIONS NOTES:**

(N) 40 year ac shingles Class 'C'

MOISTLIRE BARRIER

5/8" CDX Plywood Roof Sheathin

1x8 Fasci

Fascia Gutte 7/8" (3) COAT STUCCO OVER FELT-BACKED WIRE LATH PER CRC RZ03.6.2 2-LAYER OF GRADE "D" PAPER

UNDER STUCCO PER CRC R703.6.3 COLOR TO MATCH EXISTING

5/8" CDX Plywood Shear

Foundation Vent @ 8'

Weep screed at the bottom of stucco walls at min. 4" above earth or 2 above paved areas per CRC R703.6.2.1

2x6 D.F. P.T. Mudsi

Moisture Barrier

2x4 D.F. Std & Btr. Studs @ 16" O.C.

- 1. STUCCO IS TO BE APPLIED WITH A 3 COAT APPLICATION WHEN APPLIED OVER METAL LATH OR WIRE LATH PER CRC 1. STOCK IN THE SECTION OF STUCCO WALLS AT A LOCATION A MINIMUM OF 4" ABOVE EARTH OR 2".

  2. PROVIDE WEEP SCREED AT THE BOTTOM OF STUCCO WALLS AT A LOCATION A MINIMUM OF 4" ABOVE EARTH OR 2".
- 2. PROVIDE WEEP SCREED AT THE BOTTOM OF STUCCO WALLS AT A LOCATION A MINIMUM OF 4" ABOVE EARTH OR 2" ABOVE PREMA PER PCR ROT 703 ALOCATION A MINIMUM OF 4" ABOVE EARTH OR 2" ABOVE PWEED AND STAFF OF THE STUCCO IS APPLIED OVER WOOD SHEATHING FER FOR ROT 870 3.3.

  4. NO BAVE VENTS ARE ALLOVED WHERE SHEAR TRANSFER IS REQUIRED AT FRIEZE BLOCK.

  5. PROVIDE GUINAVEZED STEEL METAL FLASHING AND COUNTER FLASHING AT ALL ROOF TO WALL AND CHAINLY STREAM AND COUNTER FLASHING AND C

#### CRAWLSPACE VENTING CALCULATIONS: (CONSIDERING CLOSED BENTS)

Required 356 Sq.Ft \* 1/150 = 2.38 Sq.Ft \* 144 = 342.72 Sq.In = Required (5) 14" x 6" = 84 Sq.In for each \* (5) = 420 Sq.In > 342.72 Sq.In (Okay)

### ATTIC VENTILATION CALCULATIONS: (CONSIDERING CLOSED VENTS)

Required 356 Sq.Ft.\* 1/150 = 2.38 Sq.Ft. \* 144 = 342.72 Sq.In. = Required (4) 18" x 2" Eave Block Hole vent = 36 Sq.In for each \* (4) = 144 Sq.In (3) 20" x 4" Eye Brow Vent = 80 Sq.ln. for each \* (3) = 240 Sqln. Total = 144 + 240 = 384 > 342.72 Sq.ln. (Okay)

NOTE: CONTRACTOR TO COMPENSATE ADDITIONAL (MIN. 5) VENTS FOR BOTH BLOCKED CRAWLSPACE VENTILATION & ROOF VENTILATION ON THE EXISTING HOUSE.



A CONTRACTOR OF THE PROPERTY O						
COMMENT OR REVISION NO.	DATE:	BY:				

PROJECT:

1620 Beth Way Campbell, CA 95008

APN:403-13-054

SHEET TITLE :

ARCHITECTURAL ELEVATION PROPOSED

DESIGNER STAMP

10/22/2018 SHEET

**A-07** 

TYP. WALL CROSS SECTION

NOT TO SCALE

2x4 D.F. Std & Btr. Fire Block

R-13 Wall Insulation

7000.7000.7U

PER STRUCTURAL ERAMING


R-30 Ceiling Insulation

2x6 D.F. Std & Btr. Floor Joists @ 16" O.C




# PROPOSED STREET ESCAPE

SCALE N.T.S.

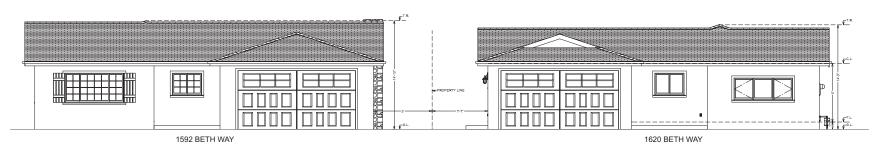

# PROPOSED FRONT ELEVATION NEIGHBORING PROPERTIES

SCALE N.T.S.

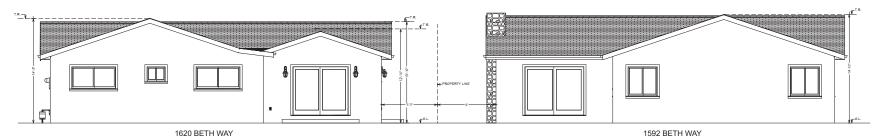

# PROPOSED REAR ELEVATION NEIGHBORING PROPERTIES

SCALE N.T.S.

WISE SUITERS

COMMENT OR REVISION NO.	DATE:	BY:			

PROJECT:

1620 Beth Way Campbell, CA 95008

APN:403-13-054

SHEET TITLE :

ARCHITECTURAL ELEVATION PROPOSED

DESIGNER STAMP:

DATE: 10/22/2018

HEET ·

A-08

#### FLOOR PLAN NOTES:

- ALL WINDOWS SHALL BE DUAL PANE LINLESS OTHERWISE NOTED AND SAFETY GLASS (TEMPERED ALL WINDOWS STALL BE DOLL FAIL ONCESS AND WINDOWS ADJACENT TO DEPLINES, ALL WINDOWS IN BATHS, AND IN WINDOWS WHERE EXPOSED BOTTOM EDGE OF GLAZING IS LESS THAN 18" ABOVE FLOOR.
- CONTRACTOR TO PROVIDE CERTIFICATE OF COMPLIANCE FOR INSULATION FOR R-15 WALL, R-30 ATTIC
- WATER METER MUST BE INSTALLED PRIOR TO FINAL INSPECTION AND MUST NOT BE LOCATED IN DRIVE OR APPROACH WHERE REQUIRED.
- ALL WEATHER STRIPPING, CAULKING, AND SEALING OF EXTERIOR DOORS, WINDOWS AND BLDG ENVELOPE OPENINGS, AS REQUIRED BY THE C.R.C. SHALL BE SUBJECT TO FIELD INSPECTION.
- ALL MANUFACTURED DOORS AND WINDOWS SHALL BE CERTIFIED AND LABELED
- NALLING SPECIFIED WITHIN THE STRUCTURE CALCULATIONS AND DETAIL SHALL BE DONE USING COMMON NAILS. PROVIDE I.C.C APPROVAL PRIOR TO THE INSTALLATION OF AN ALTERNATE FASTENER. - PIPING IN UNCONDITIONED SPACE LEADING TO AND FROM WATER HEATERS SHALL BE INSULATED WITH AN INSTALLED THERMAL RESISTANCE OF R-3 OR GREATER FOR FIVE FEET OF PIPE CLOSEST TO THE WATER HEATER, OR WHATEVER SHORTER I ENGTH IS IN UNCONDITIONED SPACES
- FOR KITCHEN, A CLEAR PASSAGEWAY OF NOT LESS THAN 3-FEET BETWEEN THE COUNTER FRONTS AND APPLIANCE OR COUNTER FRONTS AND WALLS, CRC 1208 1

#### BATHROOMS & KITCHEN:

- a. 22" MIN SHOWER DOOR CLEARANCE
- b. TEMPER GLAZING FOR THE SHOWER DOOR AND SLIDING WINDOWS. CEMENT BOARD SUBSTRATE FOR SHOWER WALLS
- c. LAVATORY FACETS TO HAVE A FLOW RATE OF 1.2 GPM OR LESS AT 60 PSI. ( CALGREEN 4.303.1)
- d. WATER CLOSETS TO HAVE A FLOW THAT NOT EXCEEDS 1.28 GPF. TANK-TYPE WATER CLOSET SHALL BE CERTIFIED TO THE PERFORMANCE CRITERIA OF THE U.S. EPA WATERSENSE SPECIFICATION FOR TANK-TYPE TOILETS. (CALGREEN 4.303.1)
- e. THE EFFECTIVE FLUSH VOLUME OF URINALS SHALL NOT EXCEED 0.5 GPF f. CEMENT BOARD SUBSTRATE (IE. DUROCK OR WONDERBOARD.ETC) FOR TILE APPLICATION
- SURROUNDING THE BATH TUR WALLS.
- g. KITCHEN FAUCETS TO HAVE A FLOW RATE OF 1.8 GPM OR LESS AT 60 PSI. (CALGREEN 4.303.1)
- SHOWER COMPARTMENTS AND WALLS ABOVE BATHTUBS WITH INSTALLED SHOWER HEADS SHALL BE FINISHED WITH A NONABSORBENT SURFACE TO HEIGHT NOT LESS THAN 6 FEET ABOVE THE FLOOR PER CRC R307.2
- . SINGLE SHOWERHEAD: SHOWERHEADS SHALL HAVE A MAX. FLOW RATE OF NOT MORE THAN 2.0 GPM AT 80 PSI, SHOWER HEADS SHALL BE CERTIFIED TO THE PERFORMANCE CRITERIA OF THE U.S. EPA WATER SENSE SPECIFICATION FOR SHOWERHEADS.
- j. MULTIPLE SHOWERHEADS: COMBINED FLOW RATE OF ALL SHOWERHEADS AND/OR SHOWER OUTLETS CONTROLLED BY A SINGLE VALVE SHALL NOT EXCEED 2.0 GPM @ 80PSI OR ONLY ONE SHOWER OUTLET IS TO BE IN OPERATION AT A TIME. (CALGREEN 4.303.1.3.2)

  k. RESIDENTIAL LAVATORY FAUCETS. THE MAX FLOW RATE OF RESIDENTIAL LAVATORY FAUCETS SHALL
- NOT EXCEED 1.5 GPM AT 60 PSI. THE MIN. FLOW RATE OF RESIDENTIAL LAVATORY FAUCETS SHALL NOT BE LESS THAN 0.8 GPM AT 20 PSI. (CALGREEN 4.303.1.5)
- LI AVATORY FALICETS IN COMMON AND PUBLIC USE AREAS. THE MAX FLOW RATE OF LAVATORY FALICETS INSTALLED IN COMMON AND PUBLIC USE AREAS (OUTSIDE OF DWELLINGS OR SLEEPING UNITS) IN RESIDENTIAL BUILDINGS SHALL NOT EXCEED 0.5 CPM AT 60 PSI.
- m. METERING FAUCETS. METERING FAUCETS WHEN INSTALLED IN RESIDENTIAL BUILDINGS SHALL NOT DELIVER MORE THAN 0.25 GALLONS PER CYCLE.
- n. IRRIGATION CONTROLLERS. AUTOMATIC IRRIGATION CONTROLLERS INSTALLED AT THE TIME OF FINAL INSPECTION SHALL BE WEATHER OR SOIL MOISTURE-BASED.
- ALL HOSE BIBBS INSTALLED SHALL BE PROTECTED BY AN APPROVED NON-REMOVABLE TYPE BACK FLOW PREVENTION DEVICE.
- BATHROOMS, WATER CLOSET COMPARTMENTS, LAUNDRY ROOMS, ETC., SHALL BE PROVIDED WITH NATURAL VENTILATION BY MEANS OF OPENABLE EXTERIOR OPENINGS WAN AREA OF NOT LESS THAN 1/20 OF THE FLOOR AREA W/MIN. OF 1-1/2 SQ.FT. OR 5 AIR CHANGES PER HOUR.
- WALL SURFACE BEHIND CERAMIC TILE OR OTHER FIN. WALL MATERIALS SUBJECT TO WATER SPLASH SHALL BE CONSTRUCTED OF MATERIALS NOT ADVERSELY AFFECTED BY WATER. (APPROVED WR GYP. BD. INSTALLED ACC. TO C.B.C 4712.)
- PRIOR TO BUILDING FINAL INSPECTION AN 'APPLIANCE CERTIFICATE'. SIGNED BY THE INSTALLER OR GEN. CONTRACTOR, SHALL BE POSTED IN A CONSPICUOUS LOCATION.

#### TUB/SHOWER AND WATER CLOSET REQUIREMENTS

- a. THE MIXING VALVE IN A SHOWER (INCLUDING OVER A TUB) SHALL BE PRESSURE BALANCING SET AT A MAXIMUM DEGREE F. THE WATER-FILLER VALVE IN BATHTUBS/WHIRLPOOLS SHALL HAVE A TEMPERATURE LIMITING DEVICE SET AT A MAXIMUM OF 120 DEGREE F. THE WATER HEATER THERMOSTAT CANNOT BE USED TO MEET THESE PROVISIONS (CPC 403 3 409 4)
- NEW OR RECONFIGURED SHOWER STALL SHALL BE A MINIMUM FINISHED INTERIOR OR 1,024 SQUARE INCHES, BE CAPABLE OF ENCOMPASSING A 30 INCH DIAMETER CIRCLE. ANY DOORS SHALL SWING OUT OF THE ENCLOSURE, HAVE A CLEAR OPENING OF 22 INCHES MINIMUM (CPC 408.5, 408.6) 22.
  c. SHOWER STALLS AND BATHTUB WITH SHOWER HEADS INSTALLED, SHALL HAVE WALLS FINISHED WITH 23.
- A NON-ABSORBENT SURFACE FOR A MINIMUM OF 6 FEET ABOVE FLOOR (CBC 1210 AND CBC R307.2)
- d. THE WATER CLOSET SHALL HAVE A CLEARANCE OF 30 INCHES WIDE (15 INCHES ON CENTER) AND 24 INCHES IN FRONT (CPC 402.5)
- e. WHERE THE WATER CLOSET (OR OTHER PLUMBING FIXTURE) COMES INTO CONTACT WITH THE WALL OR FLOOR THE JOINT SHALL BE CAULKED AND SEALED TO BE WATERTIGHT (CPC 402.2)
- LOCATE AND EXPOSE ALL PROPERTY CORNERS AND STRING THE SIDE YARD PROPERTY LINES PRIOR TO FOUNDATION INSPECTION.

# INSULATION NOTES:

AFTER INSTALLING INSULATION, THE INSULATION INSTALLER SHALL POST IN A CONSPICUOUS LOCATION IN THE BUILDING A CERTIFICATE SIGNED BY THE INSTALLER AND THE BUILDER STATING THAT THE INSTALLATION CONFORMS WITH THE REQUIREMENTS OF TITLE 24, PART 2, CHAPTER 2 53, AND THE MATERIALS INSTALLED CONFORM WITH THE REQUIREMENTS OF TITLE 24, CHAPTER 2, SUB CHAPTER 2, ART. 3. THE CERTIFICATE SHALL STATE THE MANUFACTURER'S NAME AND MATERIALS INSTALLED 'R' VALUE, AND (IN APPLICATIONS OF LOOSE FILL INSULATION), THE MINIMUM INSTALLED WEIGHT PER SOLIARE FOOT CONSISTENT WITH THE MANUFACTURER'S LARRED DENSITY FOR THE DESIRED 'P'

BUILDER SHALL PROVIDE THE ORIGINAL OCCUPANT WITH A LIST OF THE HEATING, COOLING, WATER HEATING AND LIGHTING SYSTEMS AND CONSERVATION OR SOLAR DEVICES INSTALLED IN THE BUILDING AND INSTRUCTIONS ON HOW TO USE THEM EFFICIENTLY. SEC. 1403(e) TITLE 24, CALCS.

#### **GENERAL NOTES:**

- ALL WORK SHALL BE DONE IN ACCORDANCE WITH LOCAL CITY COLINTY AND STATE STANDARDS AND SECTIONS OF CBC, CRC, CALIFORNIA ENERGY CODE, CPC, CEC, IN THE EVENT OF CONFLICT, THE HIGHER STANDARDS AND SPECIFICATIONS SHALL PREVAIL.
- IT IS THE RESPONSIBILITY OF THE CONTRACTOR TO VERIFY HORIZONTAL AND VERTICAL LOCATIONS
  OF ALL EXISTING UTILITIES PRIOR TO COMMENCING WORK. THE DESIGNER ASSUMES NO RESPONSIBILITY FOR LOCATION OF EXISTING LITHLITIES. SHOWN OR NOT SHOWN ON PLANS
- ELEVATIONS AND DISTANCES SHOWN ON PLANS ARE APPROXIMATE AND MAY VARIES. IT SHALL BE THE CONTRACTOR RESPONSIBILITIES TO VERIFY SUCH ELEVATIONS AND DISTANCES IN THE FIELD
- PRIOR TO COMMENCING WORK, ALL NECESSARY BUILDING, PLUMING, ELECTRICAL PERMITS SHALL BE OBTAINED FROM THE APPROVED AGENCY BY THE OWNER/CONTRACTOR AT HIS COST
- THE CONTRACTOR SHALL COORDINATE ALL WORK WITH OTHER SUBCONTRACTORS, PG&E, PACIFIC BELL AND OTHER PARTICIPANT ENTITIES.
  FIELD VERIFY ALL WORK AND DIMENSIONS PRIOR TO CONSTRUCTION.
- USE 2X4 STUDS @ 16" O.C. DF#2. AND AN EXTRA STUD UNDER TRUSS
- FINGER JOINTED STUDS IN STRUCTURAL WALLS (BEARING OR SHEAR) SHALL BE APPROVED AND ARE NOT ALLOWED AT HOLDOWN LOCATIONS
- ALL SLIDING GLASS DOORS, SHOWER DOORS AND TUB ENCLOSURES SHALL BE TEMPERED GLASS AND LABELED SAFETY GLAZING. ALL WINDOWS SHALL MEET THE MINIMUM STANDARD AS ESTABLISHED BY THE CRC
- PROVIDE AN EXHAUST FAN CAPABLE OF PROVIDING 75 CFM TO REST ROOMS.
- FLASH ALL EXTERIOR OPENINGS W/G,I, OR ALUMINUM ON KRAFT PAPER OR 15# FELT. SO AS TO BE TOTALLY WATER PROOF AS PER CBC 1402.
- PROVIDE SMOKE ALARMS AT ALL BEDROOMS & HALLWAYS AS REQUIRED (MIN. 3' FROM AC RETURN/
- NAILING SHALL MEET REQUIREMENTS OF CBC TABLE 2304.9.1. CRC R602.3(1).

#### ADDITIONAL NOTES:

- JOB CARDS TO BE AVAILABLE FOR SIGNATURE AT JOB SITE.
  PROVIDE A DIMENSIONED COPY OF THE FLOOR PLAN FOR THE COUNTY ASSESSOR'S OFFICE.
- PROVIDE CERTIFICATE OF COMPLIANCE OR OTHER CERTIFICATE OF FEES PAID FROM THE SCHOOL DISTRICT HAVING JURISDICTION OVER THE SITE FOR PROPOSED CONSTRUCTION.
- ADDRESS NUMBERS TO BE VISIBLE FROM THE ROAD WITH NUMERALS THAT ARE 4" HIGH OR HIGHER.
- SURFACE WATER SHALL BE DRAINED AWAY FROM THE BUILDING FOR THE FIRST 5' BY AT LEAST 2% GRADE. THE OVERALL LOT DRAINAGE MUST BE NOT LESS THAN 1%.
- A FIRE ESCAPE WINDOW SHALL BE PROVIDED IN EVERY BEDROOM WHERE THERE IS NOT A DOOR TO THE EXTERIOR WITH A SILL HIGH OF NOT MORE THAN 44" ABOVE THE FLOOR, SUCH WINDOW SHALL HAVE A CLEAR OPERABLE AREA OF NOT LESS THAN 5.7 SOLET, WITH NO DIMENSION LESS THAN 24"
- IN HEIGHT OR 20" IN WIDTH THAT WILL OPEN ONTO A STREET, ALLEY, YARD OR EXTERIOR COURT. MINIMUM FINISHED WIDTH FOR A CORRIDOR IS NOT LESS THAN 36".
- WATER CLOSET (TOILET) COMPARTMENT MUST HAVE NOT LESS THAN 15" CENTERLINE OF BODET TO RIM AND NOT LESS THAN 24" CLEAR IN FRONT OF THE UNIT AS PER CPC 407.6.
- BETWEEN GARAGE AND RESIDENCE INSTALL MINIMUM 1/2" GYPSUM BOARD ONE-HOUR FIRE-RESISTANT WALLBOARD FROM CONCRETE TO ROOF SHEATHING OF GARAGE SIDE OF ALL COMMON
- GLASS WINDOWS AND DOORS THAT ARE SUBJECT TO HUMAN IMPACT. WITH 24" OF DOOR, CLOSER THAN 60" ABOVE AN EXTERIOR WALKING SURFACE OR WITHIN 18" OF AN INTERIOR FLOOR MUST BE
- TEMPERED GLASS OR REQUIRES A PROTECTIVE GRILL AS PER CRC R308.4. WATER HEATERS, FURNACES AND ELECTRIC OUTLETS MUST BE INSTALLED AT LEAST 18" ABOVE
- GARAGE FLOOR OR CONCRETE SLAB. STRAP WATER HEATER FOR SEISMIC BRACING. LATH PLASTER SHALL COMPLY WITH SECTION 2512.1. PROVIDE WEEP SCREEDS NOT LESS THAN 4" ABOVE THE EARTH OR NOT LESS THAN 2" ABOVE
- PAVED AREAS. FOAM TYPE LINDERLAY REQUIRES A WATERPROOF FACING STLICCO. SUBMIT SPECIFICATIONS AND ICC REPORT NUMBER OF TYPE TO BE USED
- SHOWER STALLS AND TUBS ENCLOSURES TO HAVE SAFETY GLAZING. SHOWER DOORS MAY NOT BE LESS THAN 22" MINIMUM WIDTH
- MECHANICAL VENTILATION SYSTEMS MUST SUPPLY 5 AIR CHANGES PER HOUR IN BATH AND LAUNDRY ROOMS
- PROVIDE 12" SQ. TUB ACCESS OR SOLVENT WELD TUB TRAP JOINTS PER CPC.
- PROVIDE BACKDRAFT DAMPERS TO ALL VENTS TO THE OUTSIDE.

  DISTANCE BETWEEN RANGE TOP AND CABINET ABOVE SHALL NOT BE LESS THAN 30"
  UNPROTECTED, 24" PROTECTED AND NOT LESS THE RANGE MANUFACTURERS SPECS. FOR HORIZONTAL DISTANCE (OR MIN. 6" IF NOT SPECIFIED).
- WATERPROOF GYPSUM BOARD UNDERLAY AT SHOWERS, TUBS AND OTHER SURFACES ADVERSELY AFFECTED BY WATER IS NOT ALLOWED AS PER GA-216 OR ASTM C840.
  INTERIOR WALL SURFACES TO BE 1/2" GYPSUM WALLBOARD (FLAMESPREAD GLASS III OR BETTER)
- UNI ESS SPECIFIED OTHERWISE.
- BUGSCREEN TO BE INSTALLED PRIOR TO FINAL INSPECTION.

  NEW ROOFING TO BE CLASS "C" ROOF COVERING OR BETTER. THE INSTALLER SHALL PROVIDE A CERTIFICATION TO THE BUILDING DIVISION PRIOR TO FINAL INSPECTION

#### ADDITIONAL NOTES:

- 1) ALL PENETRATIONS INTO UNCONDITIONED SPACES (I.E. ATTIC, UNDER FLOOR, ETC.) SHALL BE CAULKED, GASKETED, WEATHER-STRIPPED, OR SEALED TO LIMIT INFILTRATION AND EXFILTRATION.
- 2) THE HOT WATER PIPE FROM THE WATER HEATER TO THE KITCHEN WILL BE INSULATED. (2016 CALIFORNIA ENERGY REGULATIONS 15(1)8 D)
- 3) ALL PLUMBING VENTS SHALL TERMINATE NOT LESS THAN 6" ABOVE ROOF NOR LESS THAN 1' FROM ANY VERTICAL
- 3) ALL PLUMBING VENTS SHALL TERMINATE NOT LESS THAN 6" ABOVE ROOF NOR LESS THAN 1" FROM ANY VERTICAL SURFACE. VENTS SHALL TERMINATE NOT LESS THAN 10" FROM OR 3" ABOVE ANY WINDOW, DOOR, OPENINATE, AR INTAKE, OR VENT SHAFT NOR 3" FROM LOT LINE. (2016 CPC 906)

  14 CLOTHES DRYRE EXHAUST WILL TERMINATE AT THE EXTERNOR OF THE BUILDING, AND WILL BE A MAXIMUM OF 14" IN LENGTH WITH A MAXIMUM OF TWO 90 DEGREE ELBOWS, (2016 CMC 504.3,2,2)
- 5) THE AIR CONDITIONING REFRIGERANT LINES MUST BE PROTECTED FROM UV DETERIORATION. (CALIFORNIA ENERGY
- (CALIFORNIA ENERGY CODE 150M2D)

  CALIFORNIA ENERGY CODE 150M2D)



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1620 Beth Way Campbell, CA 95008


APN:403-13-054

SHEET TITLE

ARCHITECTURAL FLOOR PLAN NOTES

DESIGNER STAMP

10/22/2018

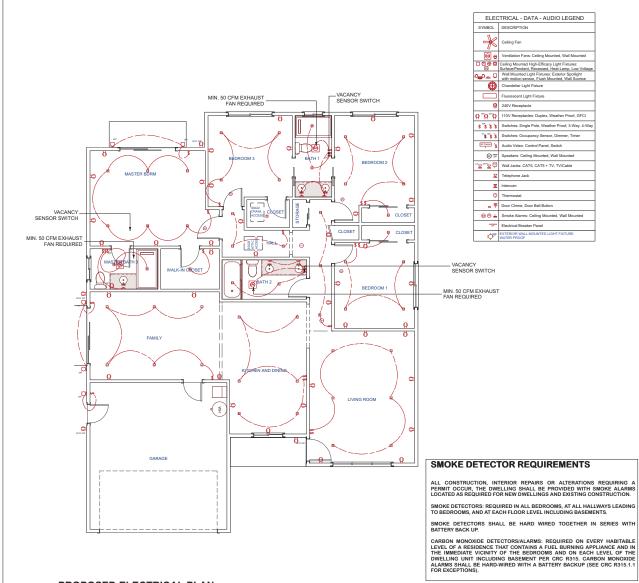

**ELECTRICAL NOTES** 

ELECTRICAL INSTALLATION SHALL BE IN ACCORDANCE WITH THE LATEST EDITION OF NATIONAL ELECTRICAL CODE (NEC), ELECTRICAL SAFETY ORDERS, STRIE OF CASH FORMA AND ALL APPLICABLE LEGOAL CODES.

ALL EXHAUST FASA SHALL HAVE MINS ADON (MYENTED THAN LOOP) TYPICAL WITH THAN APPERS.

SMOKE DETECTORS SHALL BE HARD-WIRED DIRECT TO THE BUILDING'S ELECTRICAL SYSTEM. INTERCONNECTED AND SHALL HAVE MINS ADDRESS.

SMOKE DETECTORS SHALL BE HARD-WIRED DIRECT TO THE BUILDING'S ELECTRICAL SYSTEM. INTERCONNECTED AND SHALL HAVE SHALL FROM THE STRIP AND STATEST AND THE STRIP AND THE S

NOGENDE ASSESSMENT OF THE MEDICAL EXPENSION OF THE MEDICAL DESIGNATION OF T

O. DISHWASHED.

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D. FRONT AND REAR SPRINKLER OUTLETS

TABATHUB, THERE SHALL BE NO CORD CONNECTED FIXTURES, HANGING FIXTURES, PENDANTS, LIGHTING TRACK, OR CEILING FANS AI IDAITIUB, THERE SHALL BE NO CORD CONNECTED FIXTURES, HANGING FIXTURES, PENDANTS, LIGHTING TRACK, OR CEILING FAN INCC 410-4(d) BATHROOM RECEPTACLES MUST BE SERVED BY A SEPARATE 20 AMP BRANCH CIRCUIT WITH NO OTHER OUTLETS SERVED FROM THAT CIRCUIT.

B. BATHROOMS

THE BUILDING STEEL AND THE SECRET AND WATER HEATING SYSTEMS. THE INSTALLER SHALL POST, IN A CONSPICUOUS LOCATION AT THE BUILDING STEEL AN INSTALLATION. CERTIFICATE (GP-4R FORM) SIGNED BY THE INSTALLER, LISTING THE GOUPMENT INSTALLER, MANUFACTURER, MODEL AND FORMER SHAD THAT THE SECRET OF DECEMBERST OF OF THE ENERGY DOCUMENTATION. WHICH IS A CONSTRUCTION OF THE SECRET AND THE ENERGY DOCUMENTATION. WHICH IS A CONSTRUCTION OF THE SECRET AND THE ENERGY DOCUMENTATION. WHICH IS A CONSTRUCTION OF THE SECRET AND THE ENERGY DOCUMENTATION. WHICH IS A CONSTRUCTION OF THE SECRET AND THE SECRET AND THE ENERGY DOCUMENTATION. WHICH IS A CONSTRUCT OF THE SECRET AND THE SECRE

FROM STRUCTURE FOR INCOMING POWER UNLESS OTHERWISE BOTTEL ELECTRICAL CONTRACTOR TO CHECK MEGICANICAL PLANE AND PUBBRIOR CARS FOR RELECTRICAL PLANE AND PUBBRIOR CARS FOR PUBBRIO

RECEPTIACLES ARE PERMITTED.
ALL BRANCH CIRCUITS THAT SUPPLY 125 VOLT, 15 AND 20 AMP OUTLETS INSTALLED IN DWELLING UNIT BEDROOMS SHALL BE PROVIDED BY ARC FAULT CIRCUIT INTERRUPTER(S), (AFCI) AS PER CEC 210-12.
REQUIRED OUTLETS: (2/01) 3 CE 2 10.528 (2/1)

REQUIRED OUTLETS: (2615 GET 4 1628) (27).

\*\*ATCHEN CONTINETORS OUTLETS REQUIRE AT LEAST TWO (2) DEDICATED CIRCUITS.

\*\*AULL SPACES ?\* OR MORE WIDE SO THAT ANY POINT IS NOT MORE THAN E FROM A RECEIPTACLE MEASURED ALONG THE FLOOR LINE.

\*\*AULL SPACES ?\*\*OR MORE WIDE SO THAT ANY POINT IS NOT MORE THAN E FROM A RECEIPTACLE MEASURED ALONG THE FLOOR LINE.

\*\*AULT SPACES ?\*\*OR MORE WIDE SO THAT ANY POINT IS NOT MORE THAN E FROM A RECEIPTACLE MAY DETERMINED AND THE FLOOR LINE.

\*\*PENISHLEAR AND BLAND COUNTER SPACES WITH A LONG DIMENSION OF 2° OR GREATER SHALL HAVE AT LEAST ONE RECEIPTACLE.

\*\*ROTE : RECEIPTACLE SHALL NOT BE INSTALLE DIMENSION OF 2° OR GREATER SHALL HAVE AT LEAST ONE RECEIPTACLE.

BAI PROUNDS, AT LEAST ONE RECEPTACLE OUTLET SHALL BE INSTALLED WITHIN 36" OF THE OUTSIDE EDGE OF EACH OUTDOOR, AT LEAST ONE RECEPTACLE OUTLET SHALL BE INSTALLED IN THE FRONT AND BACK OF A DWELLING, NOT MORE THAN 6.5" ABOVE GRADE

ABOVE

PHANCE BRANCH GROUTE.

SAIL, SEE SERVED PER A DESCRIPTION OF ALL RECEIVED PER A DESCRIPTION OF A DESCRIPTION

ELECTRICAL PANELS: FUSE BOXES, SWITCHEGAR, AND SIMLAR COUPMENT WILL BE PROVIDED WITH ADEQUATE WORKNOS SPACE, (MN. 307 WILE) AT OUR AND PT HIGH (SECE) TO, ANTENES BY A STATE OF THE PARTY O

REQUIRED LIGHTING NOTES:

A) ALL LIGHTING TO BE HIGH EFFICACY (I.E. PIN BASED CFL; PULSE -START MH, HPS, GU24 SOCKETS OTHER THAN LEDS, LED LUMINAIRES WITH INTEGRAL SOURCE, ETC) CEC TABLE 150.0A.

B) SCREW BASED PERMANENTLY INSTALLED LIGHT FIXTURE MUST CONTAIN SCREW-BASED JA8 (JOINT APPENDIX 8) COMPLIANT LAMPS. JAS COMPLIANT LIGHT SOURCES MUST BE MARKED AS "JAS-2016" OR "JA8-2016-E" CEC 150.0(K)G.

C) ALL JAS COMPLIANT LIGHT SOURCES IN THE FOLLWOING LOCATIONS ARE CONTROLLED BY VACANCY SENSORS OR DIMMERS.

T) CELLING RECESSED DAM LIGHT LUMINARIES

II) LED LUMINARIES WITH INTEGRAL SOURCES. III) PIN-BASED. LED LAMPS (MR16, AR-III, ETC.,)

IV) G0-24 BASED LED LIGHT SOURCES.

D) AT LEAST ONE FIXTURE IN EACH BATHROOM CONTROLLED BY A VACANCY SENSOR. CEC 150(K)2J. E) AT LEAST ONE FIXTURE IN EACH LAUNDRY ROOM CONTROLLED BY VACANCY SENSOR, 150(K)21,

ALL OUTDOOR LIGHTING AS HIGH EFFICACY WITH MANUAL ON/OFF SWITCH AND ONE OF THE FOLLOWING IN ACCORDANCE WITH CFC 150.0(K)3:

I) PHOTO CONTROL AND MOTION SENSOR.

II) PHOTO CONTROL AND AUTOMATIC TIME SWITCH CONTROL.

III) ASTRONOMICAL TIME SWITCH CONTROL IV) ENERGY MANAGEMENT CONTROL SYSTEMS.

COMMENT OR REVISION NO.	DATE:	BY:	

PROJECT:

1620 Beth Way Campbell, CA 95008

APN:403-13-054

SHEET TITLE

ELECTRICAL PLAN

DESIGNER STAMP

10/22/2018

SHEET

A-10

PROPOSED ELECTRICAL PLAN

SCALE 1/4"=1'-0"